


- Site Specific Notes:
- Current owner of Block 14, Lot 9R of Lone Oaks Acres, is Rueda Tabor Investment LLC & CVS Rueda Investment LLC, 1204 Carmel CT, College Station, Texas 77845, (281)-924-4682
 - Proposed use and improvements: Office/Industrial Warehouse
 - This lot is not within the 100-YR floodplain according to the DFIRM for Brazos County, Texas and Incorporated areas, Map No. 48041C0205F, effective April 2, 2014.
 - Current Zoning of the property is Industrial (I).
 - Total lot acreage is 1.594 Acres.
 - All minimum building setbacks shall be in accordance with the City of Bryan Code of Ordinances.
 - Developer/Tenant to submit electrical load information when requesting electrical service from BTU. Contact Line Design @ 821-5770.
 - Access gates shall be manually operated and secured with a chain and pad lock.
 - There are no paint spraying operations anticipated for this development.

- Construction Notes:
- All proposed sewer cleanouts that are to be placed within a concrete sidewalk shall be set at the same grade as the sidewalk and utilize a flush mount, brass cap, so that there are no tripping hazards.
 - All fill subgrade and base material shall be compacted to 98% STD in areas to be paved and 95% STD in all other areas.
 - All items to be removed during clearing and grubbing. Remove not only the above ground elements, but all underground elements as well. All excavated material shall become the property of the contractor unless otherwise directed by the Owner. All debris must be disposed of off site.
 - Prior to grading operations, contractor is to strip the first 6" of soil. Contractor shall proof roll the entire site and remove any unstable materials according to TxDOT Specifications. Select fill is to be used in replacing objectionable material.
 - Assure positive drainage across project site to the storm water structures.
 - The proposed limestone gravel pavement area shall follow the same detail and specifications as the asphalt parking lot, omitting the prime coat and asphalt-cement wearing surface. Limestone gravel surface shall be rolled smooth to finish grade.
 - Each utility contractor is responsible for positioning and trenching of service lines. Mark all lines with utility tape. Utility contractors are responsible for coordinating with paving contractor in placement and installation of any necessary utility conduit prior to subgrade preparation. Lines requiring slope control are to be installed first. All other lines not requiring slope control or elevation shall be installed deepest first. Each contractor is responsible for knowing final determination of installation order.
 - Materials and methods for pavement markings shall conform to TxDOT Standard Specifications for Construction of Highways, Streets, and Bridges (current edition), with the following exceptions: 1) Type II marking materials need not be purchased from the Department, and 2) Glass beads may be omitted, but marking material shall be Type II paint-type material.
 - Fire Sprinkler System- potable water supply must be protected by testable double check valve assembly, and install as per City Ordinance.
 - Potable Water Protection - All devices, appurtenances, appliances, and apparatus intended to serve some special function and that connects to the water supply system, shall be provided with protection against backflow and contamination of the water supply system.
 - The Contractor shall be responsible for the containment and proper disposal of all liquid and solid waste associated with this project. The Contractor shall use all means necessary to prevent the occurrence of windblown litter from the project site.
 - Demolition/Construction Waste - Site is required to provide containment for waste prior to and during demolition/construction. Solid waste roll off boxes and/or metal dumpsters shall be supplied by City to permitted contractor(s) only.
 - Where electric facilities are installed, BTU has the right to install, operate, relocate, construct, reconstruct, add to, maintain, inspect, patrol, enlarge, repair, remove, and replace said facilities upon, over, under, and across the property included in the PUE, and the right of ingress and egress on the property adjacent to the PUE to access electric facilities.

Parking Analysis:


Proposed Improvements:
360 SF Office Building
24,000 SF Limestone Gravel Yard
New Required Parking:
2... 1 Space per 300 SF Office Building
12... 1 Space per 2000 SF Yard
14... Total Required
New Provided Parking
13... Straight in Parking
1... ADA Parking
14... Total Provided

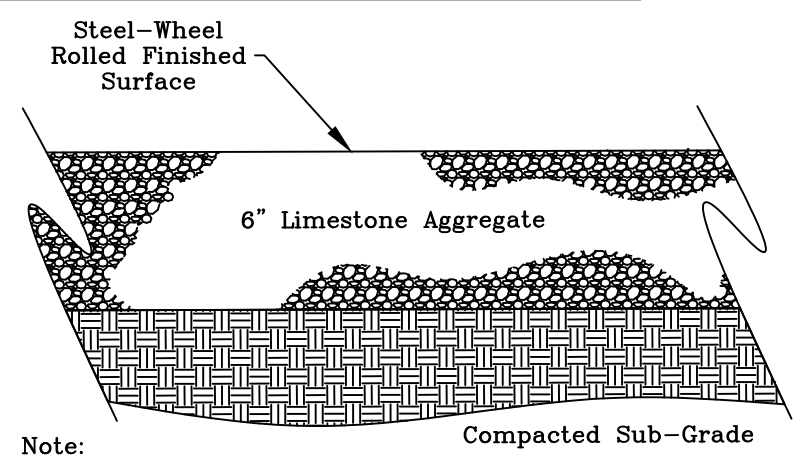

Note:

- Paving materials and procedures shall meet or exceed requirements set forth in the BCS unified standard specifications for street construction, current edition.


Typical Limestone Base Pavement Section

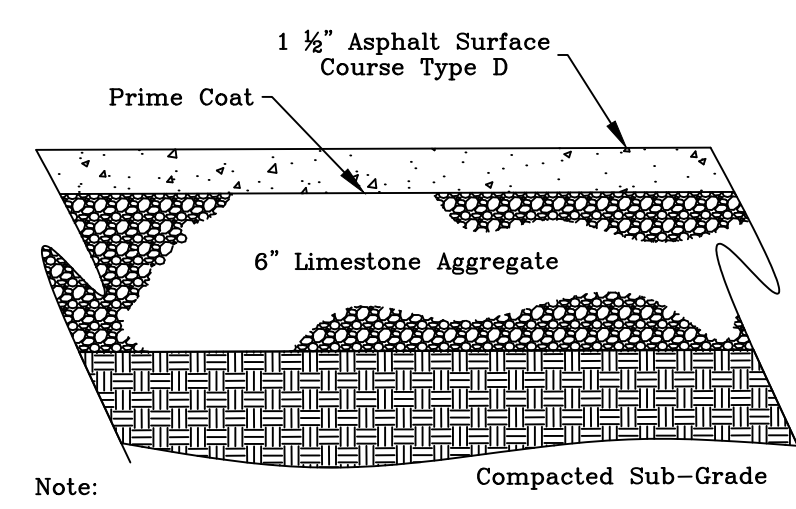


Note:

- Paving materials and procedures shall meet or exceed requirements set forth in the BCS unified standard specifications for street construction, current edition.

Typical Asphalt Pavement Section

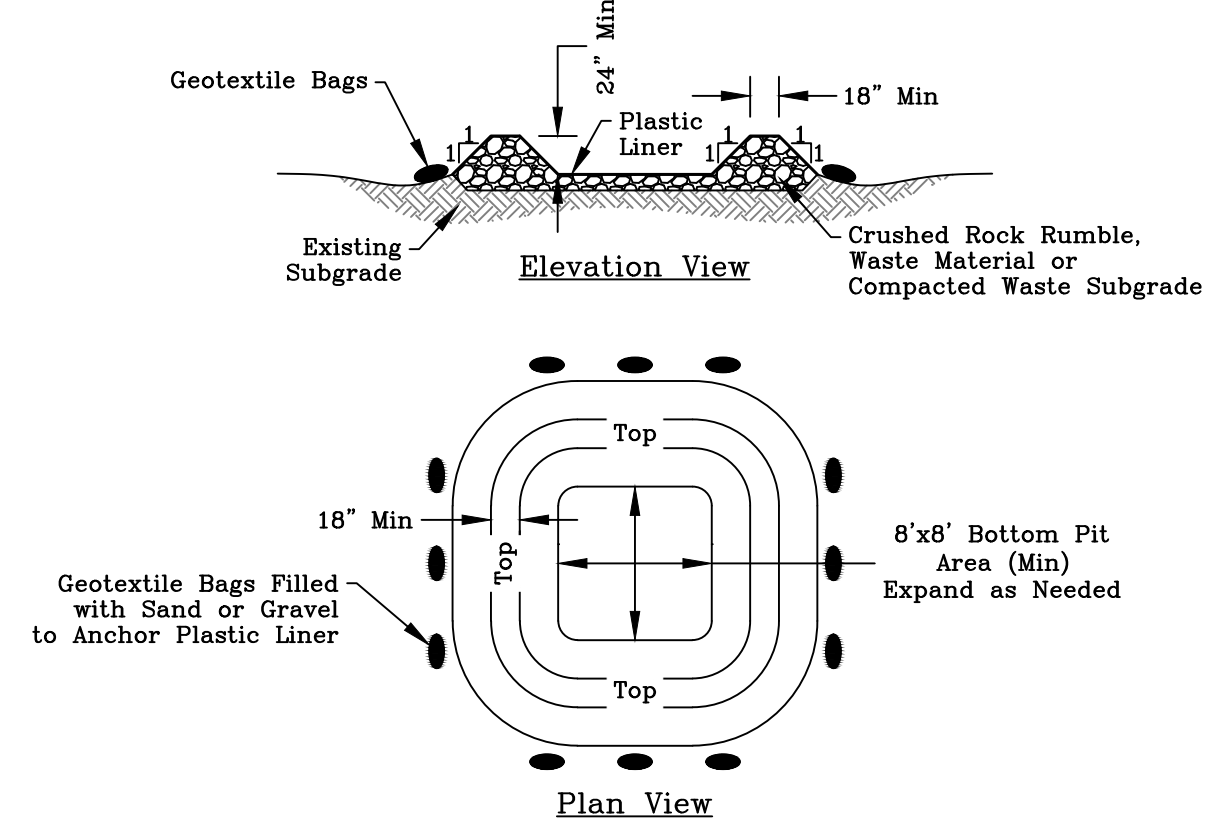

Concrete Washout

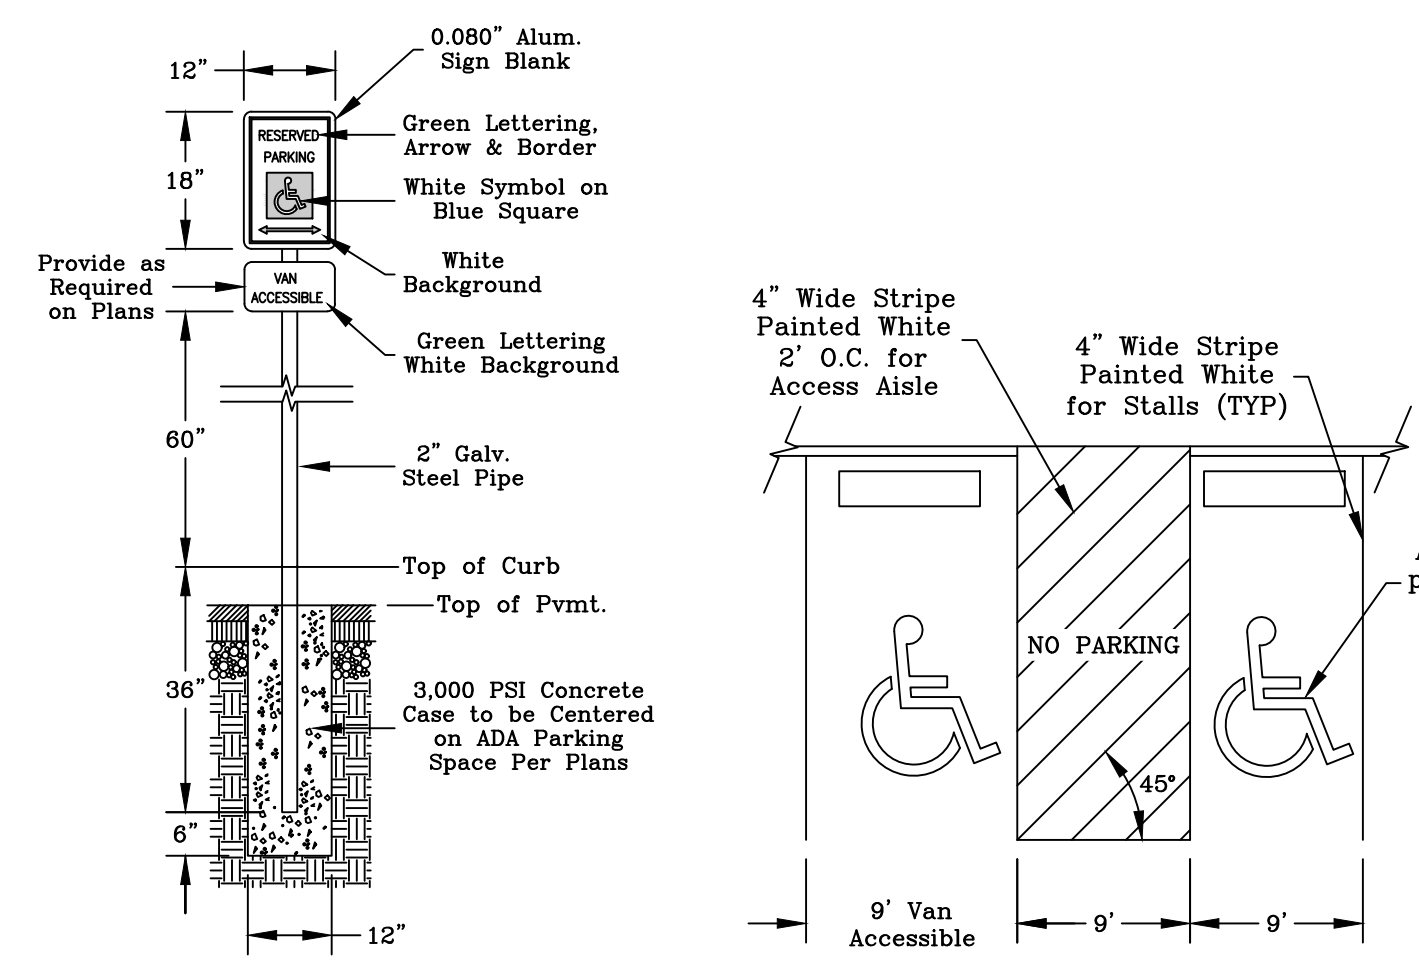


ADA Parking Sign

ADA Pavement Markings




CURVE TABLE

CURVE #	LENGTH	RADIUS	DELTA	CHORD DIRECTION	CHORD LENGTH	TANGENT
C1	39.24'	24.98'	90° 00' 00"	S 4° 07' 41" E	35.32'	24.98'

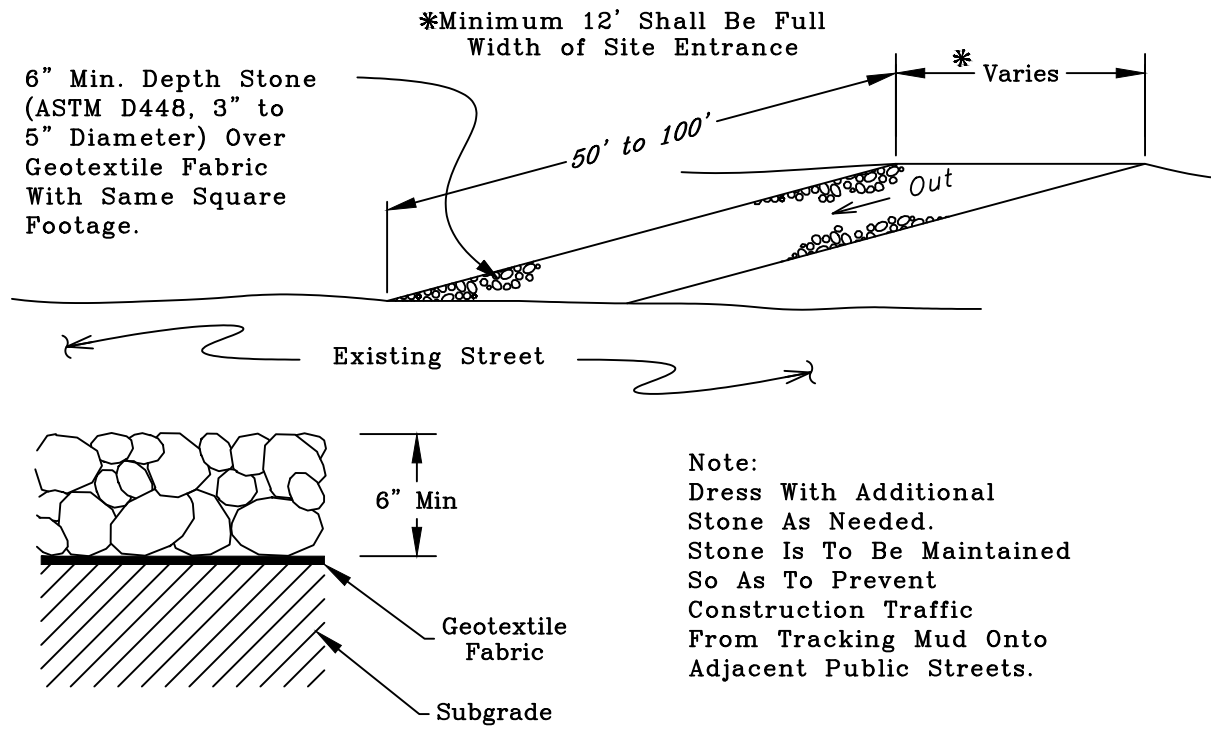

Construction Exit Detail

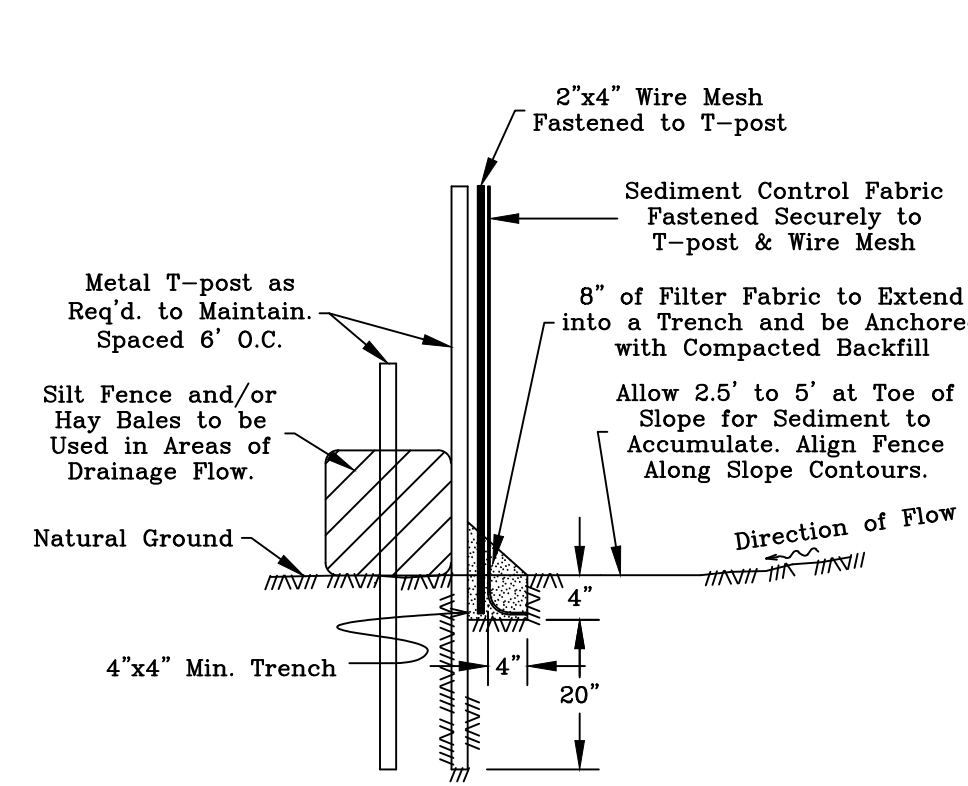

Silt Fence

Site Plan

- General Notes:
- The topography shown is from field survey data.
 - All utilities shown are taken from the best available information based on construction utility documents obtained by J4 Engineering from City and Independent agencies and/or above ground field evidence. Shown positions may not represent as-built conditions.
 - The contractor shall be responsible for verifying the exact location of all existing underground utilities, whether shown on these plans or not. Notification of the utility companies 48 hours in advance of construction is required.
 - Contractor is responsible for field verifying existing and proposed grades prior to any construction and reporting any inconsistencies to the Owner.
 - Normal Domestic Wastewater is anticipated to be discharged from this development.
 - All construction shall be in accordance with the current BCS Standard Specifications, Details, and Design Guidelines for Water, Sewer, Streets, and Drainage, unless otherwise noted.
 - It is the intent of these plans to comply with all City of Bryan guidelines, details & specifications.

Owner/Developer:
Rueda Tabor Investments, LLC &
CVS Rueda Investments, LLC
1204 Carmel CT
College Station, TX 77845

Surveyor:
Kerr Surveying, LLC
1718 Briarcrest Dr.
Bryan TX, 77802

Preliminary Plans Only Not for Construction

This document is released for the purpose of interim review under the authority of Glenn Jones, P.E. 97600 on 24-Sep-25. It is not to be used for construction, bidding, or permitting purposes.

Released for Review

No.	Revision/Issue	Date

Firm Name and Address:

J4 Engineering

PO Box 5192 - Bryan, Texas - 77805
979-739-0567 www.J4Engineering.com
Firm# 9951

Project Name and Address:

3201 Clarks Lane

Lone Oaks Acres
Block 14, Lots 9-12 - 1.594 AC

Bryan, Brazos County, Texas

Date: September 2025

Scale: As Noted

Drawn By: CB

Sheet: C1

